FOUNDATION WALL SCHEDULE				
MARK	WIDTH	REINFORCEMENT	COMMENTS	
FDN1	0' - 8"	#5 BARS @ 12" OCEW		
FDN2	0' - 8"	#5 BARS @ 18" OCEW		

FOOTING SCHEDULE							
MARK	LENGTH	WIDTH	THICKNESS	REINFORCEMENT	COMMENTS		
F1		2' - 0"	1' - 0"	(2) #5 BARS LONGITUDINAL			
F2	5' - 0"	5' - 0"	1' - 0"	#5 BARS @ 12" OCEW TOP AND BOTTOM			
F3	6' - 0"	6' - 0"	1' - 0"	#5 BARS @ 12" OCEW TOP AND BOTTOM			
F4		10' - 0"	1' - 0"	#6 BARS @ 12" OC LONGITUDINAL AND #6 BARS @ 6" OC TRANSVERSE			
F5		VARIES	1' - 0"	(2) #5 BARS TOP AND BOTTOM OCEW			

SLAB SCHEDULE							
MARK	THICKNESS	REINFORCEMENT	COMMENTS				
SL1	18"	#6 BARS @ 6" OCEW BOTTOM & #6 BARS @ 12" OCEW TOP					
SL2	6"	#6 BARS @ 10" OCEW					
SL3	6"	#5 BARS @ 12" OCEW					

PIER AND PILASTER SCHEDULE					
MARK	LENGTH	WIDTH	REINFORCEMENT	COMMENTS	
P1	2' - 2"	2' - 2"	(8) #6 BARS VERTICAL W/ #4 TIES @ 12" OC AND (3) IN THE TOP 12"		



CONSERV FS KANSASVILLE

KANSASVILLE WISCONSIN REVISION SCHEDULE DESCRIPTION 23-28114 PROJECT NO. FILE NAME 28114 Arch R24.rvt DRAWN BY KNM DESIGNED BY OA REVIEWED BY ORIGINAL ISSUE DATE 09/22/23 CLIENT PROJECT NO.

TITLE

BASE PLATE LEGEND

EQ EQ

EQ

EQ

1/4

NOTE:

1. BASE PLATES ARE SHOWN FOR REFERENCE ONLY, VERIFY WITH PEMB SUPPLIER.


1' - 9" € + 7 1/2" BP2
- 1" STEEL BASE PLATE
- (4) 314" DIA ASTM F1554 ANCHOR
BOLTS WITH NUT
- 12" EMBED
- 5" PROJECTION
- SET BASEPLATE ON 1 1/2" NONSHRINK GROUT
- PL1/4/x2x2 PLATE WASHERS

STRUCTURAL SCHEDULES


S1-05

CONTROL JOINT PLACEMENT **GUIDELINES**

- 1. SPACE JOINTS (IN FEET) NO MORE THAN 2-3 TIMES THE SLAB THICKNESS (IN INCHES), FOR EXAMPLE, A 4" SLAB SHOULD HAVE JOINTS 8" TO 12" APART.
 2. CUT JOINTS 25% OF THE DEPTH OF SLAB, MIN.
 3. CUT JOINTS 25% OF THE DEPTH OF SLAB, MIN.
 3. CUT JOINTS 25% OF THE DEPTH OF SLAB, MIN.
 3. CUT JOINTS 25% OF THE DEPTH OF SLAB, MIN.
 4. CONCRETE OR SAW CUTTING JOINTS AS SOON AS THE CONCRETE IS HARD ENOUGH THAT THE EDES ABUTTING THE CUT DON'T CHIP FROM THE SAW BLADE.
 4. IN HOT WEATHER, CONCRETE MIGHT CRACK IF JOINTS ARE NOT CUT WITHIN 6-12 HOURS AFTER FINISHING CONCRETE. PLAN ALTERNATE JOINT CUTTING EQUIPMENT ACCORDINGLY.
 5. WHERE POSSIBLE, PLACE JOINTS UNDER PROPOSED NON-LOAD-BEARING WALL LOCATIONS OR UNDER CARPET AREAS.
 6. MINIMIZE RE-ENTRANT CORNERS AND AVOID WHERE POSSIBLE.

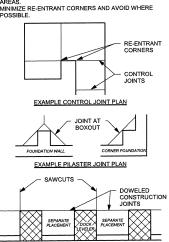

EXAMPLE MULTIPLE DOCK LEVELER JOINT PLAN

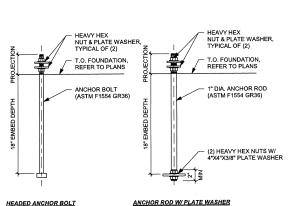


ANCHOR BOLT DETAIL

1 1/2" = 1'-0"

KEYNOTE LEGEND

1 HP1: #5 HAIRPIN W/ 4'- 0" LEGS

ISG

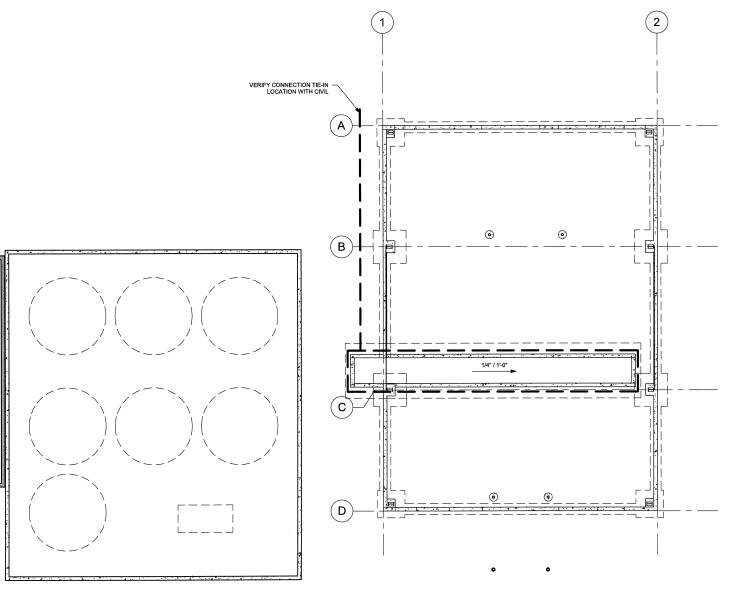

T.O. PAD 101' - 0" (D 10' - 0" 10' - 0" 10' - 0"

PIRST FLOOR CONTROL JOINT PLAN
1/8" = 1'-0"

THIS DOCUMENT IS THE PROPERTY OF I & S GROUP, INC. AND MAY NOT BE USED, COPIED OR DUPLICATED WITHOUT PRIOR WRITTEN CONSENT.

PROJECT

CONSERV FS KANSASVILLE

REVISION SCHEDULE

DATE DESCRIPTION BY

PROJECT NO. 23-28114

FILE NAME 28114 Arch R24.rvt

DRAWN BY KNM

DESIGNED BY OA

REVIEWED BY DCM

ORIGINAL ISSUE DATE 09/22/23

TITL

CLIENT PROJECT NO.

DRAIN TILE & CONTROL JOINT PLAN

SHEET

 \bigoplus^{N}

S1-21

1 DRAIN TILE PLAN
1/8" = 1'-0"

SHEET NOTES


A. REFER TO FOUNDATION DETAILS FOR TYPICAL CONSTRUCTION JOINT AND CONTROL JOINT DETAILS.
B. REFER TO CIVIL FOR GRADING

KEYNOTE LEGEND

CONFIRM HOUSEKEEPING PAD HEIGHT AND EXTENTS WITH EOR PRIOR TO INSTALLATION

12" THICKENED EDGE AROUND EXTERIOR BUILDING SLAB FOOTPRINT



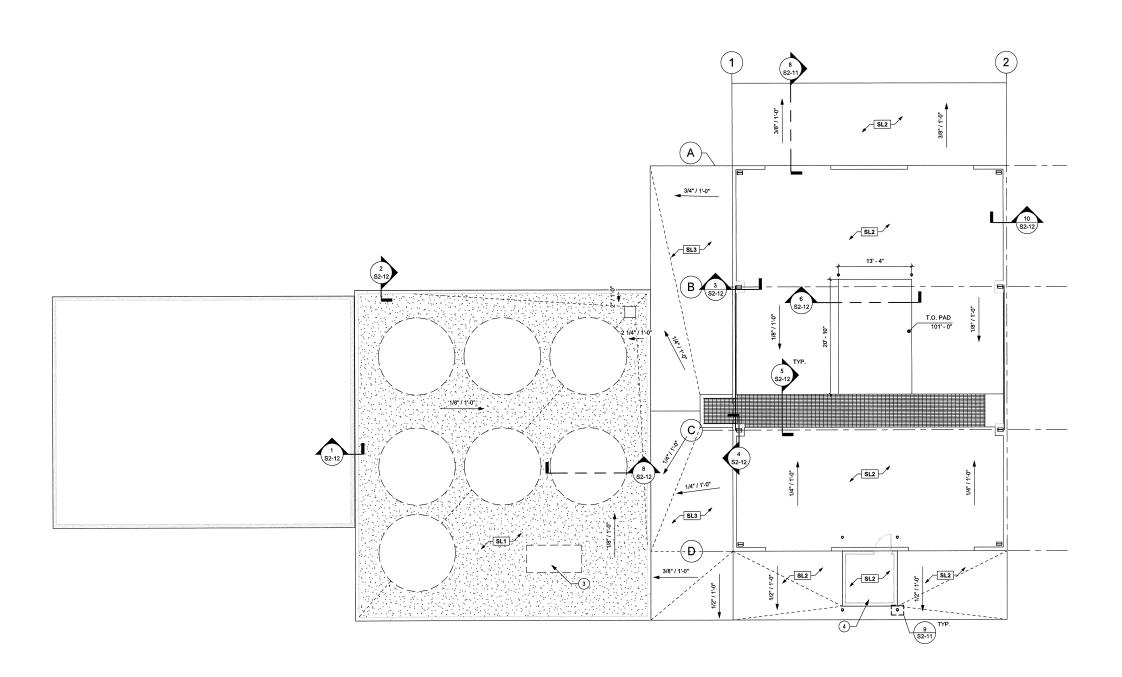

THIS DOCUMENT IS THE PROPERTY OF I & S GROUP, INC. AND MAY NOT BE USED, COPIED OR DUPLICATED WITHOUT PRIOR WRITTEN CONSENT.

CONSERV FS KANSASVILLE

REVISION SCHEDULE DESCRIPTION 23-28114 PROJECT NO. FILE NAME 28114 Arch R24.rvt DRAWN BY KNM OA DCM DESIGNED BY

REVIEWED BY CLIENT PROJECT NO.

ORIGINAL ISSUE DATE 09/22/23

SLAB PLAN

\$1-31

1) FIRST FLOOR SLAB PLAN