CONDITIONAL USE / SITE PLAN REVIEW APPLICATION	PH ITEM # 3 Racine County, Wisconsin
Owner: MUSKEGO-NORWAY SCHOOL DISTRICT	Applicant/Agent: JEREMIAH JOHNSON/CHRIS EGER
Town:NORWAY	Zoning district(s): P-1 - INSTITUTIONAL PARK DISTRICT
TO THE RACINE COUNTY ECONOMIC DEVELOPMENT & The undersigned requests a conditional use / site plan review Constact a ± 8,200 so. ft. x 30 ft. high g Elementary School	w permit to (specify use, project, structure, size, etc.)
AT (site address): 26335 Fries Lane, Wind Lake, WI 53	185
Subdivision:	
Parcel # 010-04-20-08-118-000	Section(s) 8 T 4 N R 20 E
If served by municipal sewer, check here: X Sar	nitary permit #:
Attached are:	
X zoning permit application X X 12 SETS: drawn-to-scale site plan that is based on a survey (10 of the 12 should be sized or folded to 8.5" x 11") X letter of agent status	hearing/review fee (Fees are non-refundable, & republication/amendment fees will be charged where applicable.) 3 SETS: landscaping/lighting plan 12 SETS: report/cover letter & operations plan abutting property owners' names & mailing addresses other
print name: Chris Eger - Bray Architects	e-mail address: ceger@brayarch.com
address: 829 S. 1st Street, Milwaukee, WI 53204	telephone #: 414-290-1986
	signed:
The property is all partially located in the locate	nent(s) below & underline or circle the word "all" or "partially". _akt + Was beesee Lake shoreland areashoreland area
The project is all / partially located in the wetland. The applicant is subject to the following Racine County Ord Article VI, Division 13, P-I, Institutional Park District, Section 20-1336 Public and Seni Public Uses; Sec. 20-1339 His	
Shoreland contract: yes no Public hearing date:	Site plan review meeting date:

*APPLICATION FOR ZON RACINE COUNTY, WISCO	3	DATE PERM ISSUED
· · · · · · · · · · · · · · · · · ·		
OWNER MUSKEGO-NORWAY SO	CHOOL DISTRICT	APPLICANT Chris Eger - Bray Architects
Mailing		Mailing
Address S87 W18763 WOODS F	ROAD	Address 829 S. 1st Street, Milwaukee, WI 53204
MUSKEGO W I	53150	
City State	Zip	City State Zip
Phone 262-971-1807		Phone 414-290-1986
Email jeremiah.johnson@mu	skegonorway.org	
Parcel Id. #_ 010-04-20-08-11		Site Address 26335 Fries Lane, Wind Lake, WI 53185
		Section(s) 8 Town 4 North, Range 20 East
		CSM#
D 10 1 1 7 1	المال المال	a ± 8,200 sq. ft. x 30 ft. high gymnasium addition
to the existing Lax	eview Elementa	y School
New Principa	al Bldg. X S	ize(69 x 100')(63' x 16')(26' x 13')
Addition Accessor	nrv A	Area (soft) (8700 + ala) ()
Alteration X Deck		eak Ht. (ft.) 30' (Flat) 100-Yr. Floodplain Elev. —
Conversion Sign	Î	Eave Ht. (ft.) Flood Protection Elev
		Building HtAvg. (ft.)
Temporary Other _	E	dunding HtAvg. (It.)
Contractor CG Schmidt		Est. Value w/Labor \$ 2,700,000 ZONING DISTRICT P-1
Existing Nonconforming?	N/A	Yes x No <u>Yard Setbacks</u> <u>Proposed</u> <u>OK?</u>
Structure in Shoreland? (pe		Yes X No Street-1 st
Mitigation or Buffer Needed		Yes No > Street-2 nd
Structure in Floodplain? (pe		*Yes No X Side-1st
*Structure's Fair Market Va		Cumulative % Side-2 nd
*>50% of Fair Market Value		
	r map)	Yes No λ Rear
Substandard Lot?	map)	Yes No X Total Acc. Structures
BOA Variance Needed?		
	-d-d9	Yes No Date of Approval — Date of Approval
Conditional Use/Site Plan Ne	eucu?	
Shoreland Contract Needed?	1.4: T :4	7.041.7. 0. 37. 37. 4. (7.0637. 22. 1. 1.)
Additional Zoning Permit Sti	pulations Listed	on Back of this Form? Yes No (If "Yes," see back)
The applicant hereby acknow	ledges receipt of	notice contained herein and certifies that submitted information
attachments are true and corre	ect to the best of	the knowledge and belief of the signer, and that all construction/
		g Ordinance, applicable stipulations, and Wisconsin laws.
BOA Conditional Use Site Plan CC Date Check#Cash 14643		Signature of Owner /Applicant/Agent Date
Shoreland Contract Fee	Pd: \$	Chris Eger
CC Date/Check#/Cash	Ι α. ψ	Print Name(s)

Zoning Permit Fee	Pd: \$ 200.00	
CC Date/Check#/Cash		Notes (revisions, extensions, etc.)
Other:	Pd: \$	Notes (revisions, extensions, etc.)
if shoreland erosion review		pove Zoning Administrator (Staff Initials)
Make checks payable to "Racine	County Developme	ent Services" - <u>Note</u> : ALL FEES ARE NONREFUNDABLE (OVER)

Lakeview Elementary School racine county conditional use



BRAY PROJECT NUMBER | 3394.1

Project Name

Lakeview Elementary School

Project Location

26335 Fries Ln, Wind Lake, WI 53185

Submittal Date

October 14, 2022

Submittal

Racine County - Conditional use public hearing - November 21, 2022

Owner

Muskego-Norway School District

Jeremiah Johnson

S87 W18763 Wood Road, Muskego WI 53150

Architect

Bray Architects

Chris Eger, AlA - ceger@brayarch.com - 414-290-1986

829 S. 1st Street, Milwaukee, WI 53204

Civil Engineer

Kapur and Associates

Michael Froehlich - mfroehlich@kapurinc.com - 414-659-8193

7711 N. Port Washington Road, Milwaukee WI 53217

Electrical Engineer

MSA Professional Services, Inc.

John Russell – jrussell@msa-ps.com – 920-319-8712 116 Freemont Street, P.O. Box 235, Kiel, WI 53042

Construction Manager

CG Schmidt

11777 W. Lake Park Drive, Milwaukee WI 53224

Project Narrative:

The property at 26335 Fries Ln, Wind Lake, WI 53185 is currently zoned P-1 Institutional Park District and is the current location for the existing elementary school. Educational facilities require a conditional use. The existing brick structure was designed as a mid-century building with low parapet walls and storefront windows. The proposed project consists of an 8,200 SF addition to the West side of the existing building in what is currently a parking lot. The building consists of a lower connector building which also houses storage and mechanical space with a 30 foot tall gymnasium. Materials will be brick to match the existing building up to the height of the existing building with a metal panel top. Windows will be clear anodized storefront material. Separation between existing building and new addition will be a CMU 2 hour fire wall.

All mechanical rooftop equipment will be screened from view either using proper placement behind buildings and parapets or with screening designed specifically to hide the equipment. There will be a roof ladder and school signage on the upper portion of the gymnasium facing North. The project is on municipal sewer, but has a well for water. The project addition will be fully sprinklered and will require a fire pump and tank storage located below grade.







A grass courtyard will be added and landscaped. All landscaping will be per Town of Norway requirements. Stormwater will be designed per standards as well.

All lighting will be exit wall pack lighting and will be cut-off fixtures. The electrical photometric sheet has been included.

Parking is currently provided on the site in several locations around the existing school.

Existing Elementary School
Existing enrollment =
Maximum teachers/staff =

+/- 400 students

+/- 50 teachers/staff

Operations Plan:

Typical school day hours of operation will be the same as the existing Elementary School where the school day currently starts at 8:00am and ends at 3:30pm. The building and site will be active on nights and weekends with various school groups and events including athletic practices and competitions.

Landscaping will be provided throughout the development in compliance with landscaping requirements in the zoning ordinance. The East side of the new practice facility will include tree screening.

Schedule:

The school district would like to be on the November 21, 2022 Plan Commission and public hearing meeting. A site civil package is anticipated to be issued in November to the construction manager. The balance of construction documents for the project are scheduled to be issued in December 2022. The District's construction manager, CG Schmidt, is planning to bid the project in January. Construction is anticipated to begin in March 2022 and continue through Summer 2024. The building is scheduled to open in Fall 2024 for the start of the 2024-2025 school year.











Architectural

Bray Architects 829 S. 1st Street Milwaukee, Wisconsin 53204 (414) 226-0200

Construction Manager

CG Schmidt 11777 W. Lake Park Dr. Milwaukee, Wisconsin 53224 (414) 577-1177

Civil & Landscape

Kapur & Associates, Inc. 7711 N. Port Washington Road Milwaukee, Wisconsin 53217 (414) 751-7200

Structural

Ambrose Engineering, Inc. W66 N215 Commerce Court, Suite #100 Cedarburg, Wisconsin 53012 (262) 377-7602

<u>Mechanica</u>

Fredericksen Engineering 12308 Corporate Parkway, Suite 400 Mequon, Wisconsin 53092 (262) 243-9090

Plumbing & Fire Protection

MSA Professional Services, Inc. 220 East Buffalo Street, Suite 201 Milwaukee, WI 53202 (414) 296-4333

Electrical

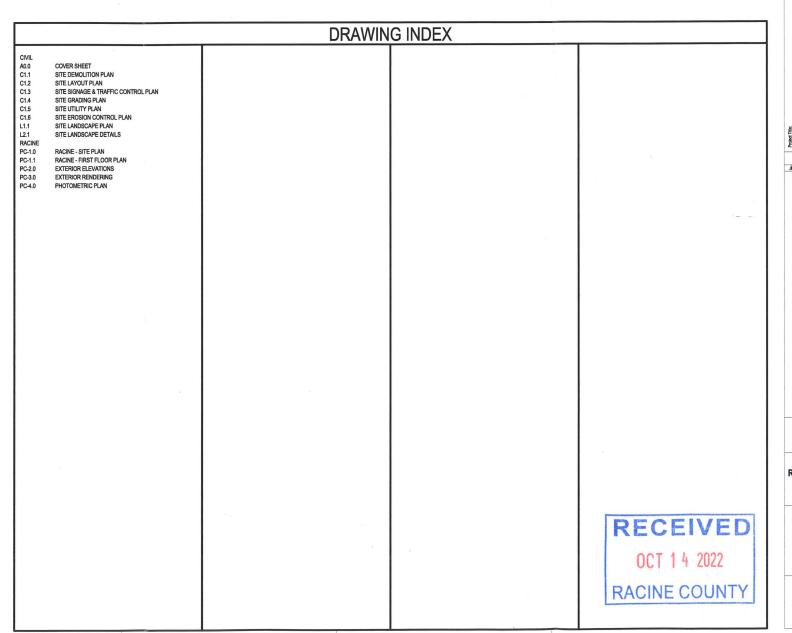
MSA Professional Services, Inc. 116 Fremont Street, PO Box 235 Kiel, Wisconsin 53042 (920) 894-7800

Addition & Renovation to:

Lakeview Elementary

Muskego Norway School District 26335 Fries Lane Wind Lake, WI 53185

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Milwaukee
829 South 1st Street
Milwaukee, Wisconsin 53204
T: 414.225.0200
Sheboygan - Davenport - Moline

dition & Renovation to: keview Elementary iskego Norway School District 335 Fries Lane

REVISIONS:

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Project Number: 3394.1

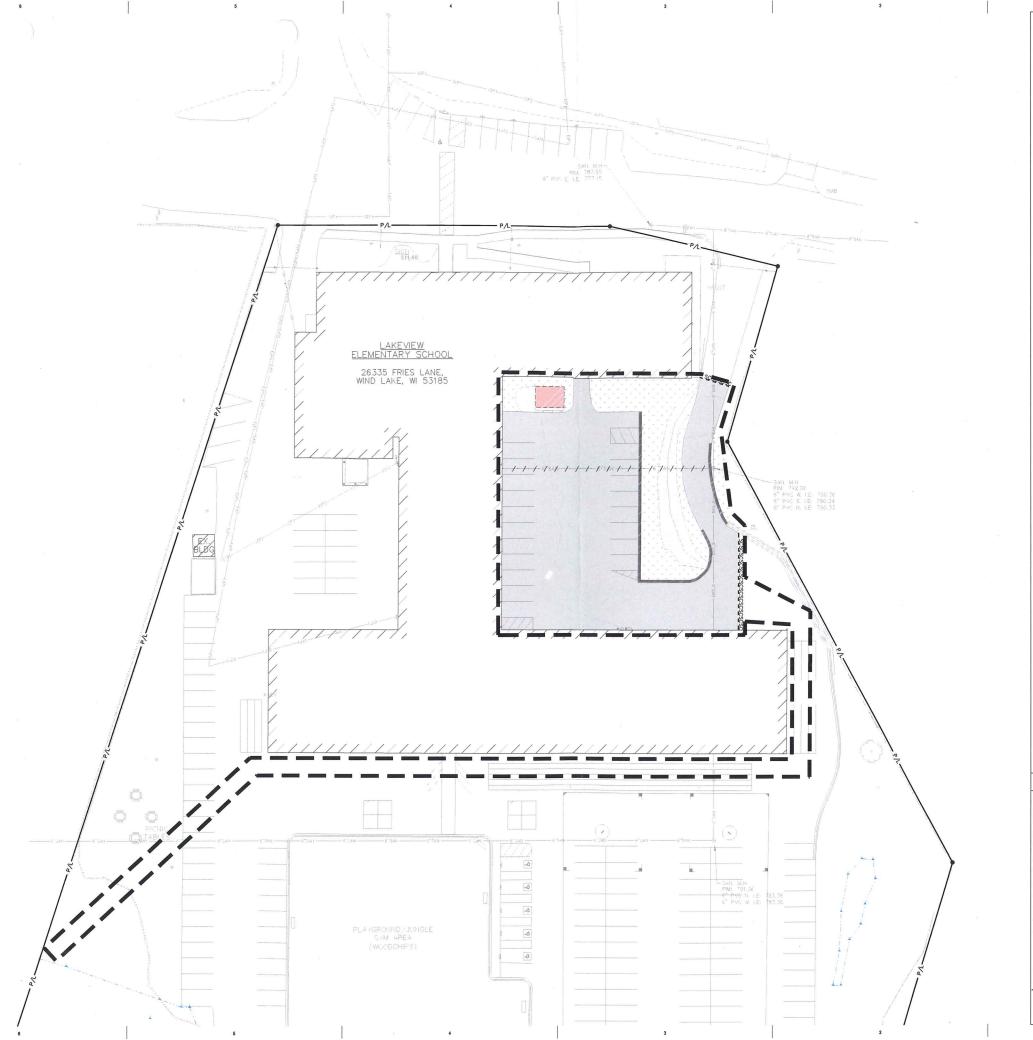
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COVER SHEET

Sheet Number:

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KEY INDEX

ABANDONED & REMOVED

CAUTION KNOWN UTILITY AND POT

-UTILITY STRUCTURE
REMOVAL/ABANDONMENT

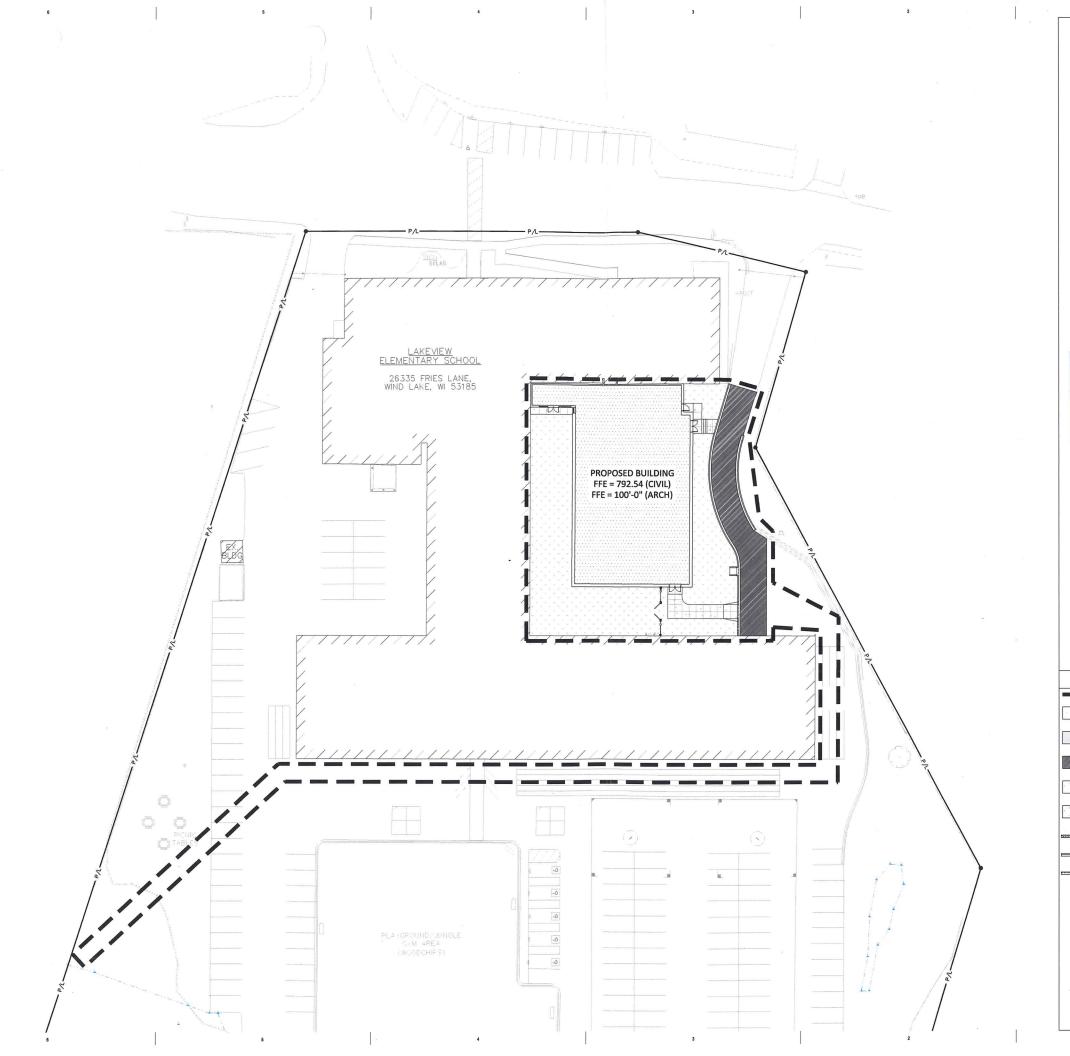
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SITE DEMOLITION PLAN







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8

NEW ACCESSIBILITY RAMP WITH TRUNCATED DOME DETECTABLE WARNING FIELDS

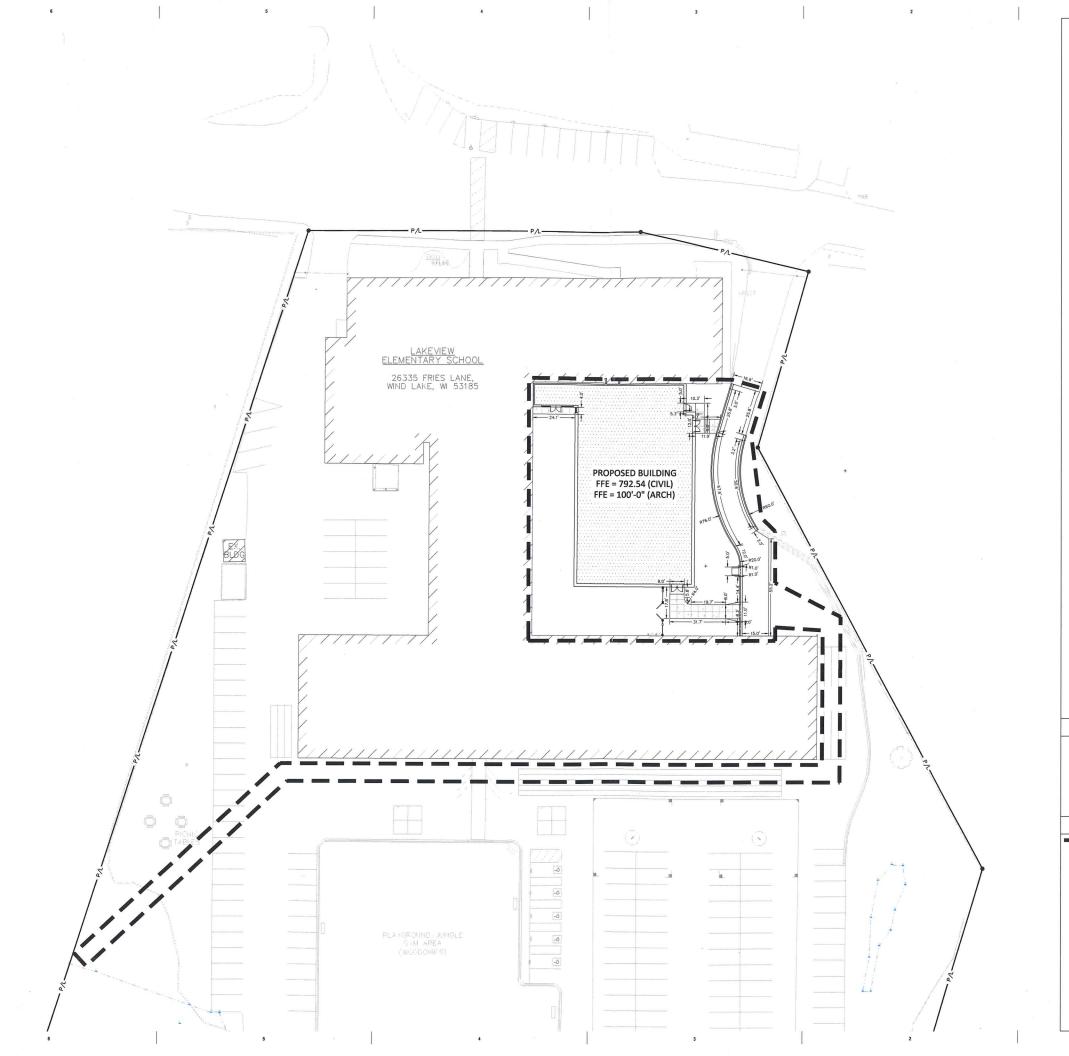
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SITE LAYOUT





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SITE SIGNAGE &

TRAFFIC CONTROL PLAN

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SIGN INDEX





KEY INDEX

PROJECT LIMITS
PAYEMENT MARKING ARROWS.
LATEX PAYEMENT MARKING PAINT, WHITE
(SEE WOOT PAYEMENT MARKING S.D.D.)

3

4 (5)

6 7

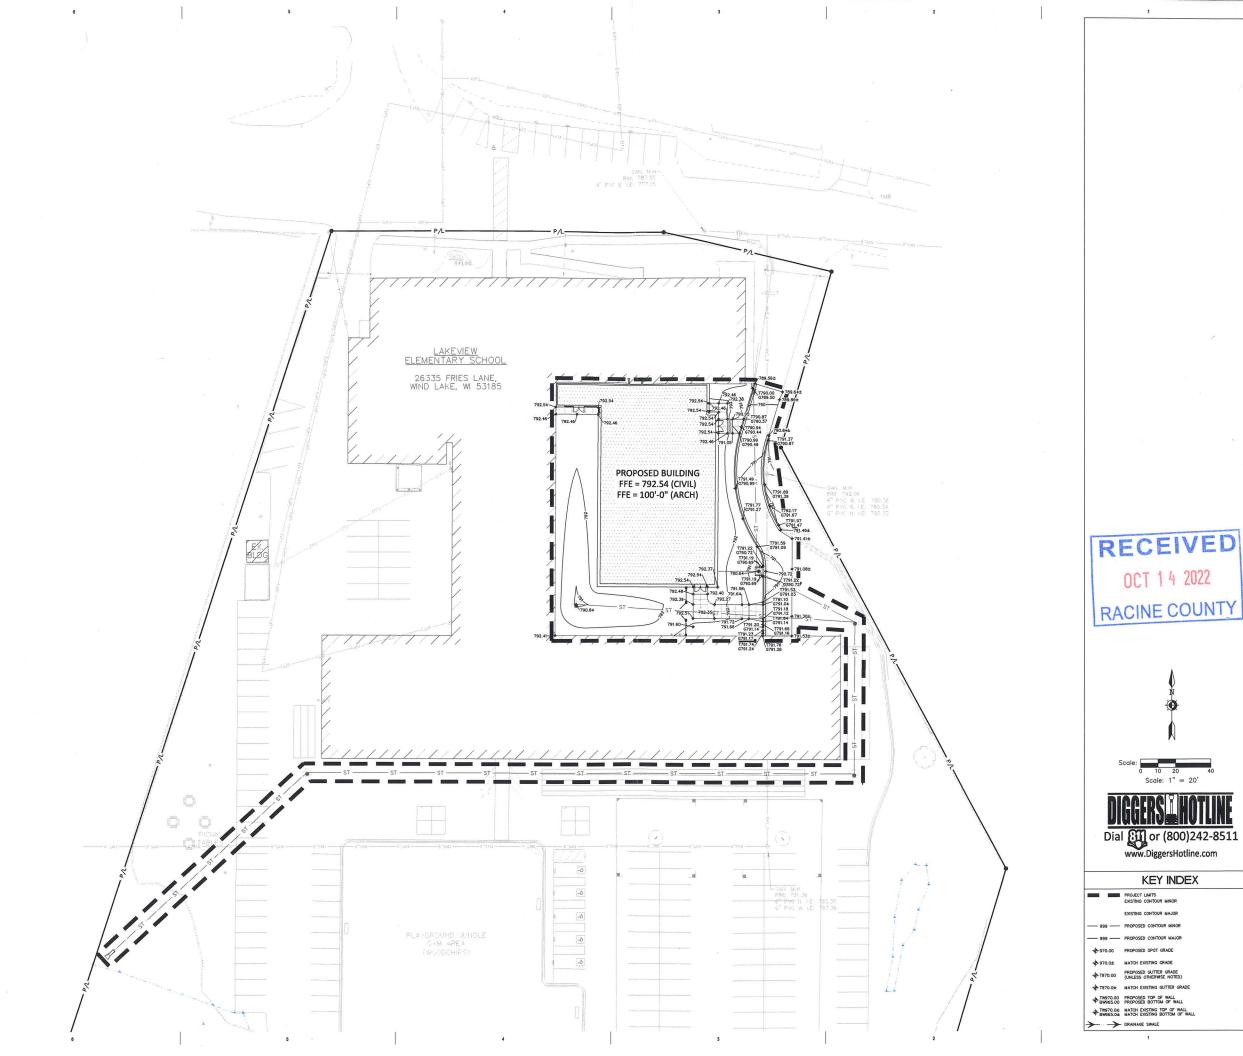
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6 C2.11 6 C2.11 6 C2.11

C1.3

Sheet Number:





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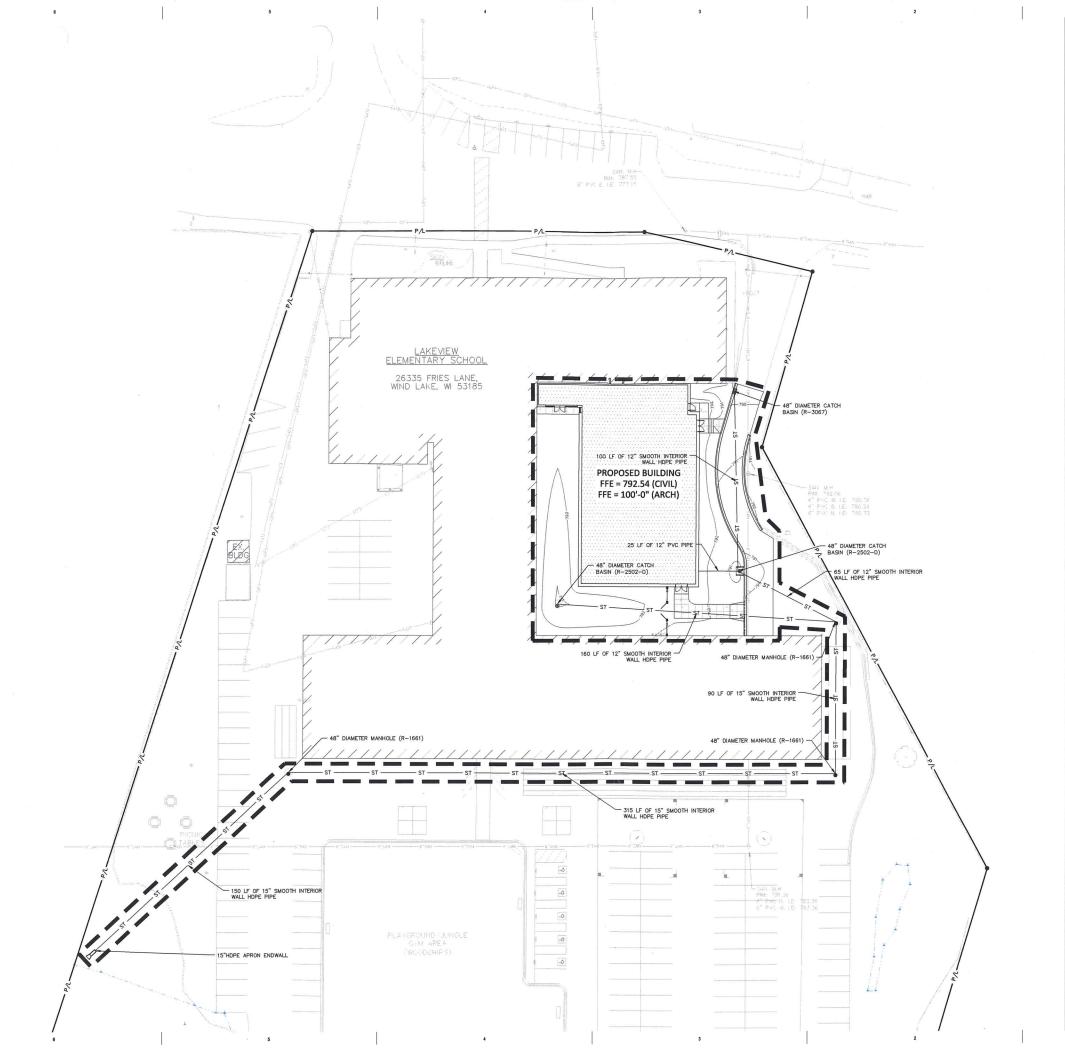
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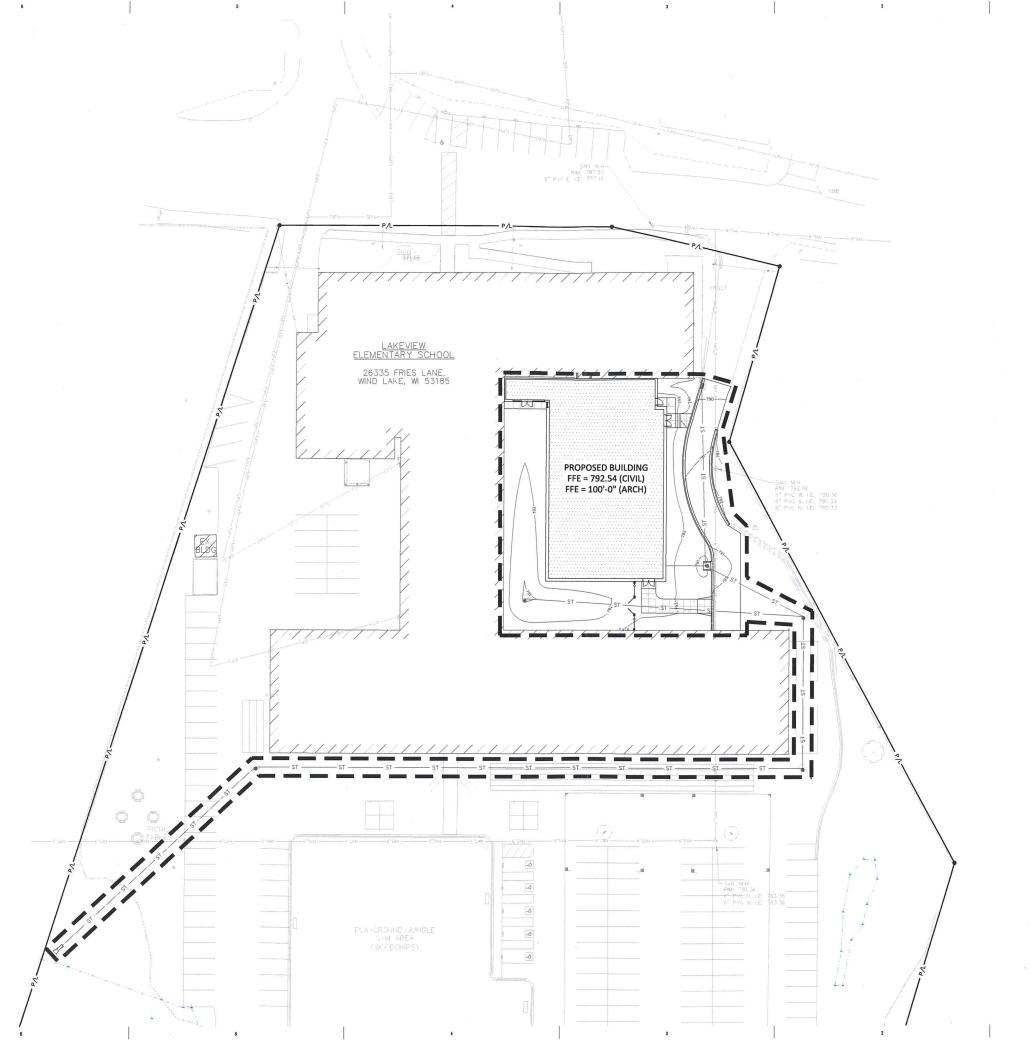
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UTILITY NOTES

KEY INDEX

THE STATE OF THE S	
STORM MANHOLE	
STORM CATCH BASIN WITH CURB BOX FRAME & GRATE	
RCP APRON ENDWALL	27 C205





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3394.1 RACINE COUNTY SUBMITTAL 10/14/2022 SITE EROSION

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EROSION NOTES

AT ABSOLUTELY NO TIME MAY CONSTRUCTION EQUIPMENT, DEBRIS, FILL, ETC. BE PLACED WITHIN WETLANDS, WATERWAYS OR FLOOD PLAINS UNLESS IDENTIFIED IN THE PLANS.

POINTS OF CONTACT

PROJECT ENGINEER: MICHAEL J. FROEHLICH, P.E. — ASSOCIATE/PROJECT

NN DUERRWAECHTER - PROJEC G. SCHMIDT 777 WEST LAKE PARK DRIVE LWAUKEE, W 53224 IONE: (414) 577-1019 n.duerrwaechter@cgschmidt.cor

KEY INDEX



PROJECT LIMITS

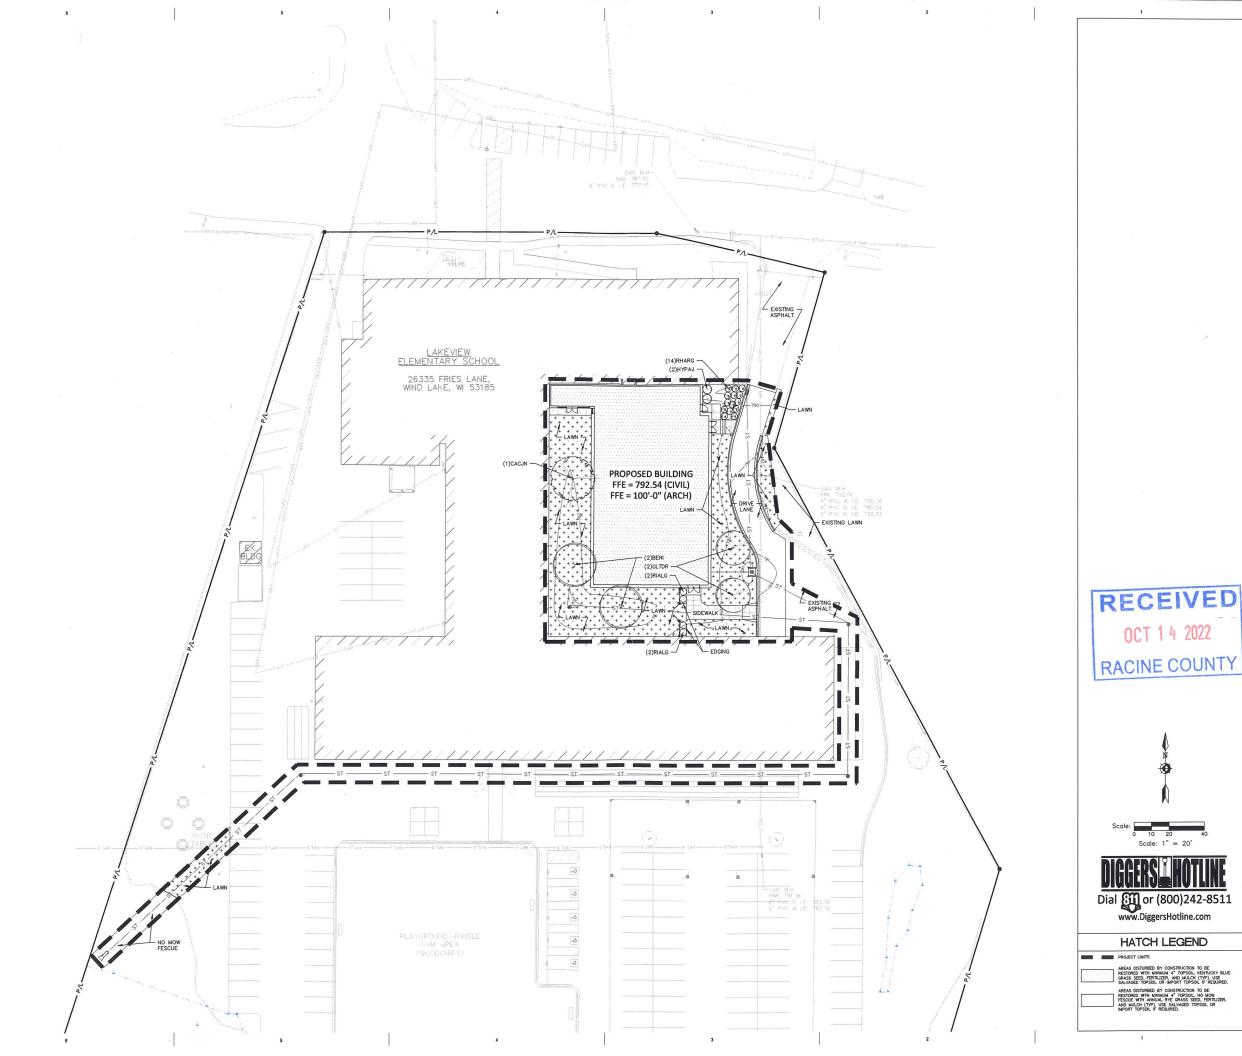
INSTALL EROSION MAT ON ALL SLOPES
GREATER THAN 4:1 AND ALL DRAINAGE
SMALES

DESIGNATES EXISTING INLETS THAT MUST BE PROTECTED

1 (202) 1 (202) 1 (202) 1 (202) 1 (202) 1 (202) 1 (202)

Sheet Number: C1.6

CONTROL PLAN





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HATCH LEGEND

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SITE LANDSCAPE PLAN

Sheet Number:

L1.1

Code	Scientific Name	Common Name	Quantity	Spacing	Install Size	Mature Size
						(Height/Spread
Canopy Tree	s: (Install according to detail 3/L2.1)					
GLTDR	Gleditsia triacanthos 'Draves'	Street Keeper Honeylocust	2	Per Plan	3" caliper B&B	45'/20'
	rees: (Install according to detail 3/L2.1)			-		
BENI	Betula nigra	River Birch	2	Per Plan	8' multi-stem B&B	40'-70'/35'-50'
CACJN	Carpinus caroliniana 'J.N. Strain'	J.N. Strain Musclewood	1	Per Plan	2.5" caliper B&B	25'-30'/25'-30'
Did 0	hh (1h					
	hrubs: (Install according to detail 4/L2.1)	Law ex				
HYPAJ	Hydrangea paniculata 'Jane'	Little Lime Hydrangea	2	Per Plan	18" tall pot	3'-5'/3'-5'
RHARG	Rhus aromatica 'Gro-Low'	Gro-Low Sumac	14	Per Plan	18" spread pot	2'-3'/6'-8'
RIALG	Ribes alpinum 'Green Mound'	Green Mound Alpine Currant	4	Per Plan	18" tall pot	3'-5'/3'-5'



- ALL PLANT MATERIAL SHALL BE OBTAINED FROM A NURSERY LOCATED IN ZONE 5, CONFORM TO APPLICABLE REQUIREMENTS
 OF THE CURRENT EDITION OF THE AMERICAN STANDARD FOR NURSERY STOCK, AND BOTANICAL NAMES SHALL BE
 ACCORDING TO THE CURRENT EDITION OF "STANDARDIZED PLANT NAMES PREPARED BY THE AMERICAN JOINT COMMITTEE ON
 HORTICULTURE NOMENCLATURE.
- 3. BARK MULCH TO BE FRESHLY ACQUIRED SHREDDED HARDWOOD BARK MULCH. NOT DOUBLE MILLED, EXCESSIVE DIRT AND DUST LIKE MATERIAL OR OLD MATERIAL IS NOT ACCEPTABLE.
- 5. ALL PLANTING AREAS TO RECEIVE A 3-INCH THICK LAYER OF SHREDDED HARDWOOD BARK MULCH OVER TYPAR WEDD FABRIC WITH EDGING. EDGING TO BE INSTALLED BETWEEN DIFFERENT TYPES OF MULCHES, BETWEEN MULCHES AND TURF, AND/OR WHERE S
- INSTALL SHOVEL CUT EDGE AROUND ALL INDIVIDUAL TREES AND SHRUBS IN LAWN AREAS AND ALONG PAVEMENT WHERE PLANTING AREAS ABUT TO PREVENT HARDWOOD SHREDDED BARK MULCH FROM SPILLING OUT OF PLANTING AREA.
- 7. CONTRACTOR RESPONSIBLE FOR MAINTENANCE OF PLANT MATERIAL FOR 90 DAYS FROM INSTALLATION, INCLUDING WATERING, WEEDING, ETC. CONTRACTOR IS RESPONSIBLE FOR MAINTENANCE OF SEEDED AREAS FOR 60 DAYS FROM INSTALLATION, INCLUDING WATERING, WEEDING, ETC. CONTRACTOR TO PROVIDE AND REVIEW MAINTENANCE INSTRUCTIONS WITH THE OWNER PRIOR TO THE COMPLETION OF THESE MAINTENANCE PERIODS. REFER TO SPECIFICATIONS FOR ADDITIONAL REQUIREMENTS.
- 8. CLEANLY PRUNE AND REMOVE DAMAGED BRANCHES, DEAD WOOD, AND ROOTS IMMEDIATELY PRIOR TO PLANTING. DO NOT CUT LEADERS OR LEAVE "V" CROTCHES OR DOUBLE LEADERS UNLESS A MULTI—STEM TREE IS SPECIFIED.
- 9. REMOVE BURLAP, WIRE BASKET, ROPE, TWINE, AND ALL SYNTHETIC MATERIAL FROM THE ROOTS, TRUNK, OR CROWN OF PLANT.
- 10. REMOVE EXCESS SOIL ABOVE TREE ROOT COLLAR (ROOT FLARE), ROOT FLARE MUST BE VISIBLE AT GRADE. ANY ADVENTITIOUS OR GIRCULOR ROOTS ARE TO BE PRUNED OFF. DIG HOLE NO DEEPER THAN THE DISTANCE FROM BASE OF ROOT BALL TO ROOT FLARE.
- 11. PLANT TREES AND SHRUBS SO THAT THE ROOT COLLAR IS 2" ABOVE FINISHED GRADE OR SEVERAL INCHES ABOVE GRADE IF PLANT IS INSTALLED IN POOR SOILS.
- 12. PLANT TREES AND SHRUBS WITH SAME ORIENTATION AS WHEN HARVESTED FROM THE NURSERY OR TO SHOWCASE THE MOST AESTHETIC VIEW.
- 13. PLANT ALL TREES WITH THREE SLOW RELEASE FERTILIZER PACKETS, SPACED EQUIDISTANT AROUND THE EDGE OF THE ROOT BALL.
- 14. PLANT ALL SHRUBS WITH ONE SLOW RELEASE FERTILIZER PACKET, PLACED BELOW THE ROOTING SYSTEM.
- 15. WATER AND TAMP BACKFILL AND ROOTS OF ALL NEWLY SET PLANT MATERIAL SO THE SOIL AND ROOTS ARE THOROUGHLY SOAKED AND AIR POCKETS ARE REMOVED.
- 16. FOR INDIVIDUAL TREES & SHRUBS PLANTED IN TURF AREAS, PROVIDE CONTINUOUS 3" SOIL SAUCER TO CONTAIN WATER & MULCH (TREES ON SLOPES SHALL BE SAUCERED ON THE DOWNHILL SIDE)
- 17. INSTALL 3" THICK SHREDDED HARDWOOD BARK MULCH RING 3'-0" DIA. FOR DECIDUOUS TREES AND ALL INDIVIDUAL SHRUBS IN LAWN AREAS, 5'-0" DIA. FOR EVERGREEN TREES. KEEP MULCH 2" AWAY FROM TRUNKS.
- 18. STAKING ONLY STAKE EVERGREEN TREES 5'-0" OR GREATER IN HEIGHT OR TREES THAT ARE UNABLE TO REMAIN UPRIGHT AFTER PLANTING. TREES WILL BECOME STRONGER FASTER WHEN THE TOP 2/3 OF THE TREE IS FREE TO SWAY. DO NOT ATTACH WIRE DIRECTLY TO TREES OR THROUGH HOSES UTILIZE GROMMETED, SYNTHETIC STRAPS AT LEAST 2" WIDE AROUND THE TREE, ATTACH STRAPPING TO STAKE WITH WIRE STAKE ONLY WHEN INCESSARY, STAKES SHOULD BE DRIVEN DEEPLY INTO THE GROUND TO PREVENT DISLODGING, CHECK AT LEAST EVERY THREE MONTHS FOR BINDING OR OTHER PROBLEMS. STAKES AND TIES SHOULD BE REMOVED SIX MONTHS TO ONE YEAR AFTER PLANTING OR ONE COMPLETE GROWING SEASON.
- 19. REFER TO SPECIFICATIONS 32 93 00 PLANTS AND 32 92 00 TURF AND GRASSES FOR ADDITIONAL INFORMATION





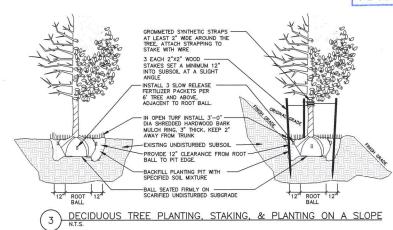
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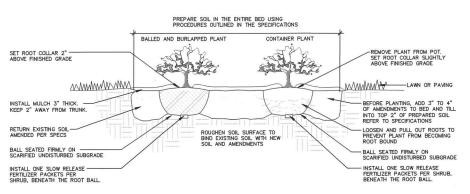


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4 DECIDUOUS & EVERGREEN SHRUB PLANTING
N.T.S.

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SITE LANDSCAPE **DETAILS**

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L2.1

6A SCHEMATIC - OVERALL SITE PLAN
Scale: 1/16" = 1'-0"



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RACINE - SITE
PLAN

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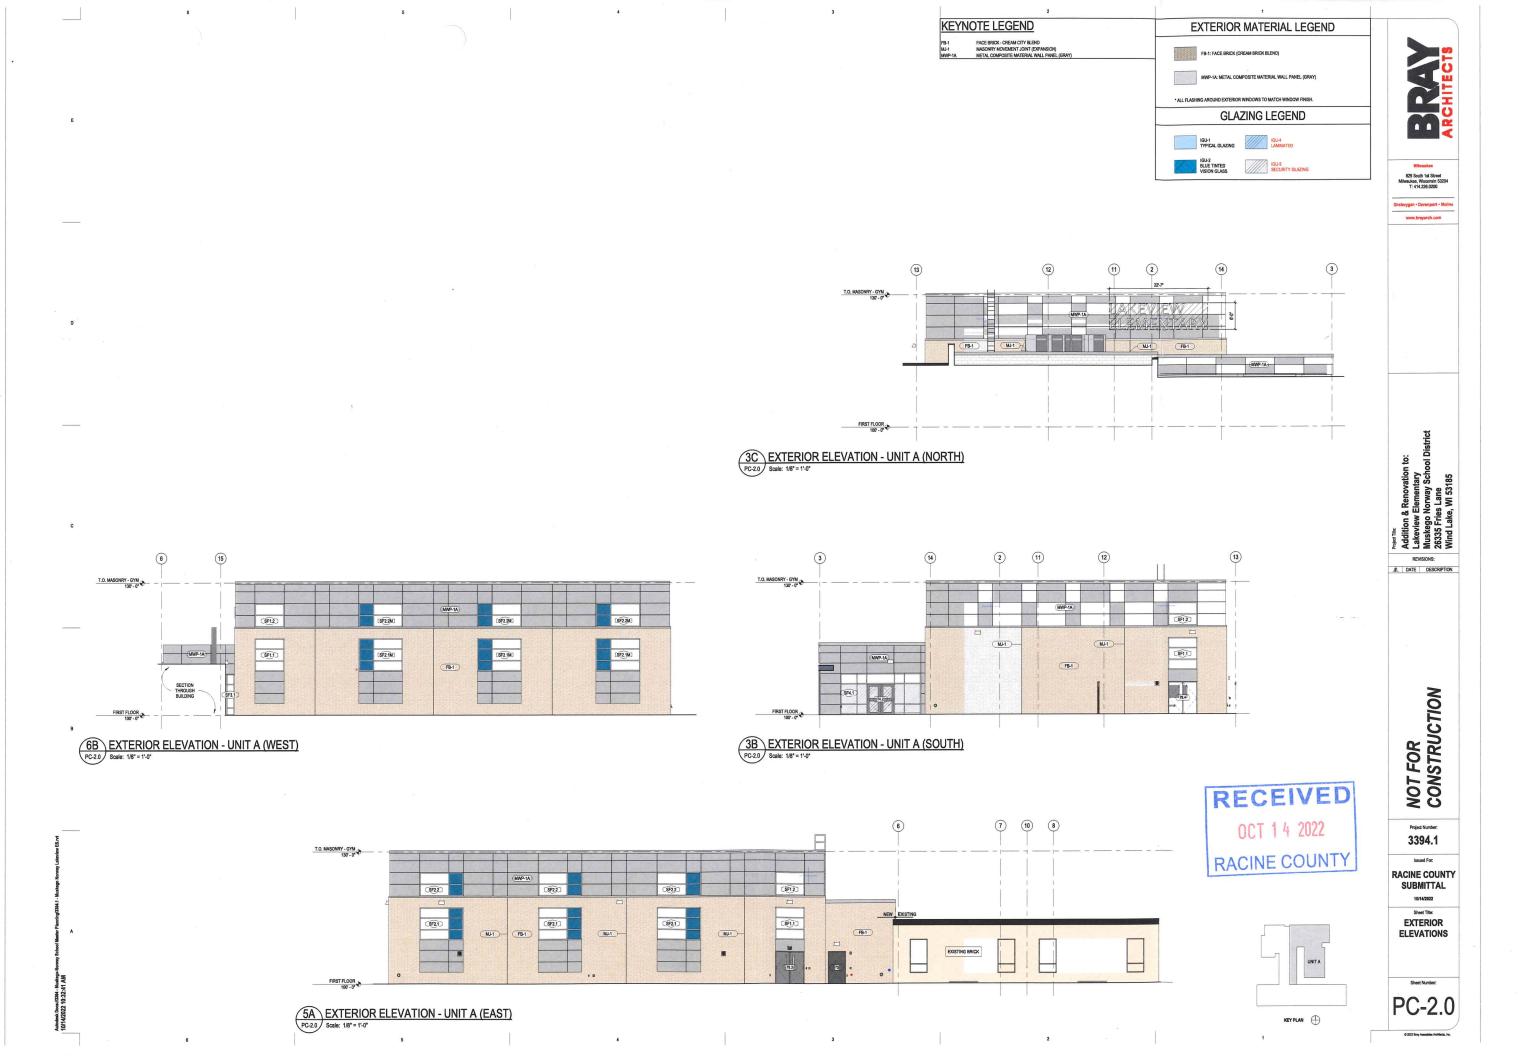
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Sheet Title:
RACINE - FIRST
FLOOR PLAN

PC-1.1



OVERALL FIRST FLOOR PLAN
PC-1.1
Scale: 1/16" = 1'-0"



PERSPECTIVE RENDERING - VIEW FROM SOUTH WEST



on & Kenovation to: ew Elementary go Norway School District Fries Lane ake. Wi 53485

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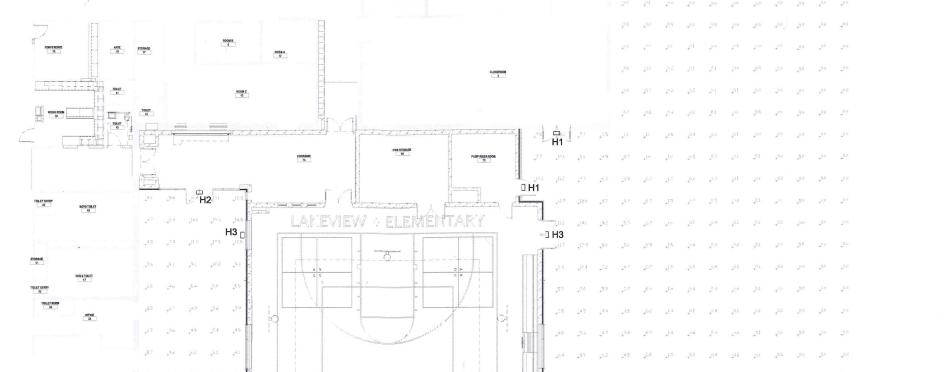
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Sheet Title:
EXTERIOR
RENDERING

Sheet Numb

PC-3.0

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ENGINEERING DESIGN BY

MASS MASS AND SECTION STATEMENT OF STATEMENT OF

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SITE PLAN - ELECTRICAL
Scale: 1/8" = 1'-0"

OYNHADAN 79

H3 [

H3 🗆

GENERAL NOTES:

1. SITE LIGHTING CALCULATED AT GRADE.

	MUSKEGO LAKEVIEW ELEMENTARY SCHOOL - FIXTURE SCHEDULE						
TYPE	DESCRIPTION	LAMP TYPE	VOLT	WATTS	MANUFACTURER	CATALOG NUMBER	NOTE
114	EXTERIOR WALL PACK - 1800 LUMENS	5000K ED 120 20	5000K LED 120 20 OPTEC	20 20 -	120 20	OLWP3S-020	
H1	EXTERIOR WALL PACK - 1000 LOMENS	JOUGH ELD	120				
H2	EXTERIOR WALL PACK - 3100 LUMENS	5000K LED	120	30	OPTEC	OLWP3S-030	
HZ:	EXTERIOR WALL PACK - 5100 COMENS	OCCUPATION OF THE PROPERTY OF	120	30			
НЗ	EXTERIOR WALL PACK - 8500 LUMENS	5000K LED	120	120 80	OPTEC	OLWP3L-080	
10000		000011228	120				
	GENERAL NOTES:						
	1. SEE SPECIFICATIONS FOR FIXTURE REQUIREMENTS,						
2. ALTE	2. ALTERNATE FIXTURES TO HAVE EQUAL CHARACTERISTICS OF SPECIFIED FIXTURES.						

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10/14/2022

ELECTRICAL SITE PLAN -PHOTOMETRIC

PC-4.0